


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NORTH BROADWAY

CESAR CHAVEZ AVE.

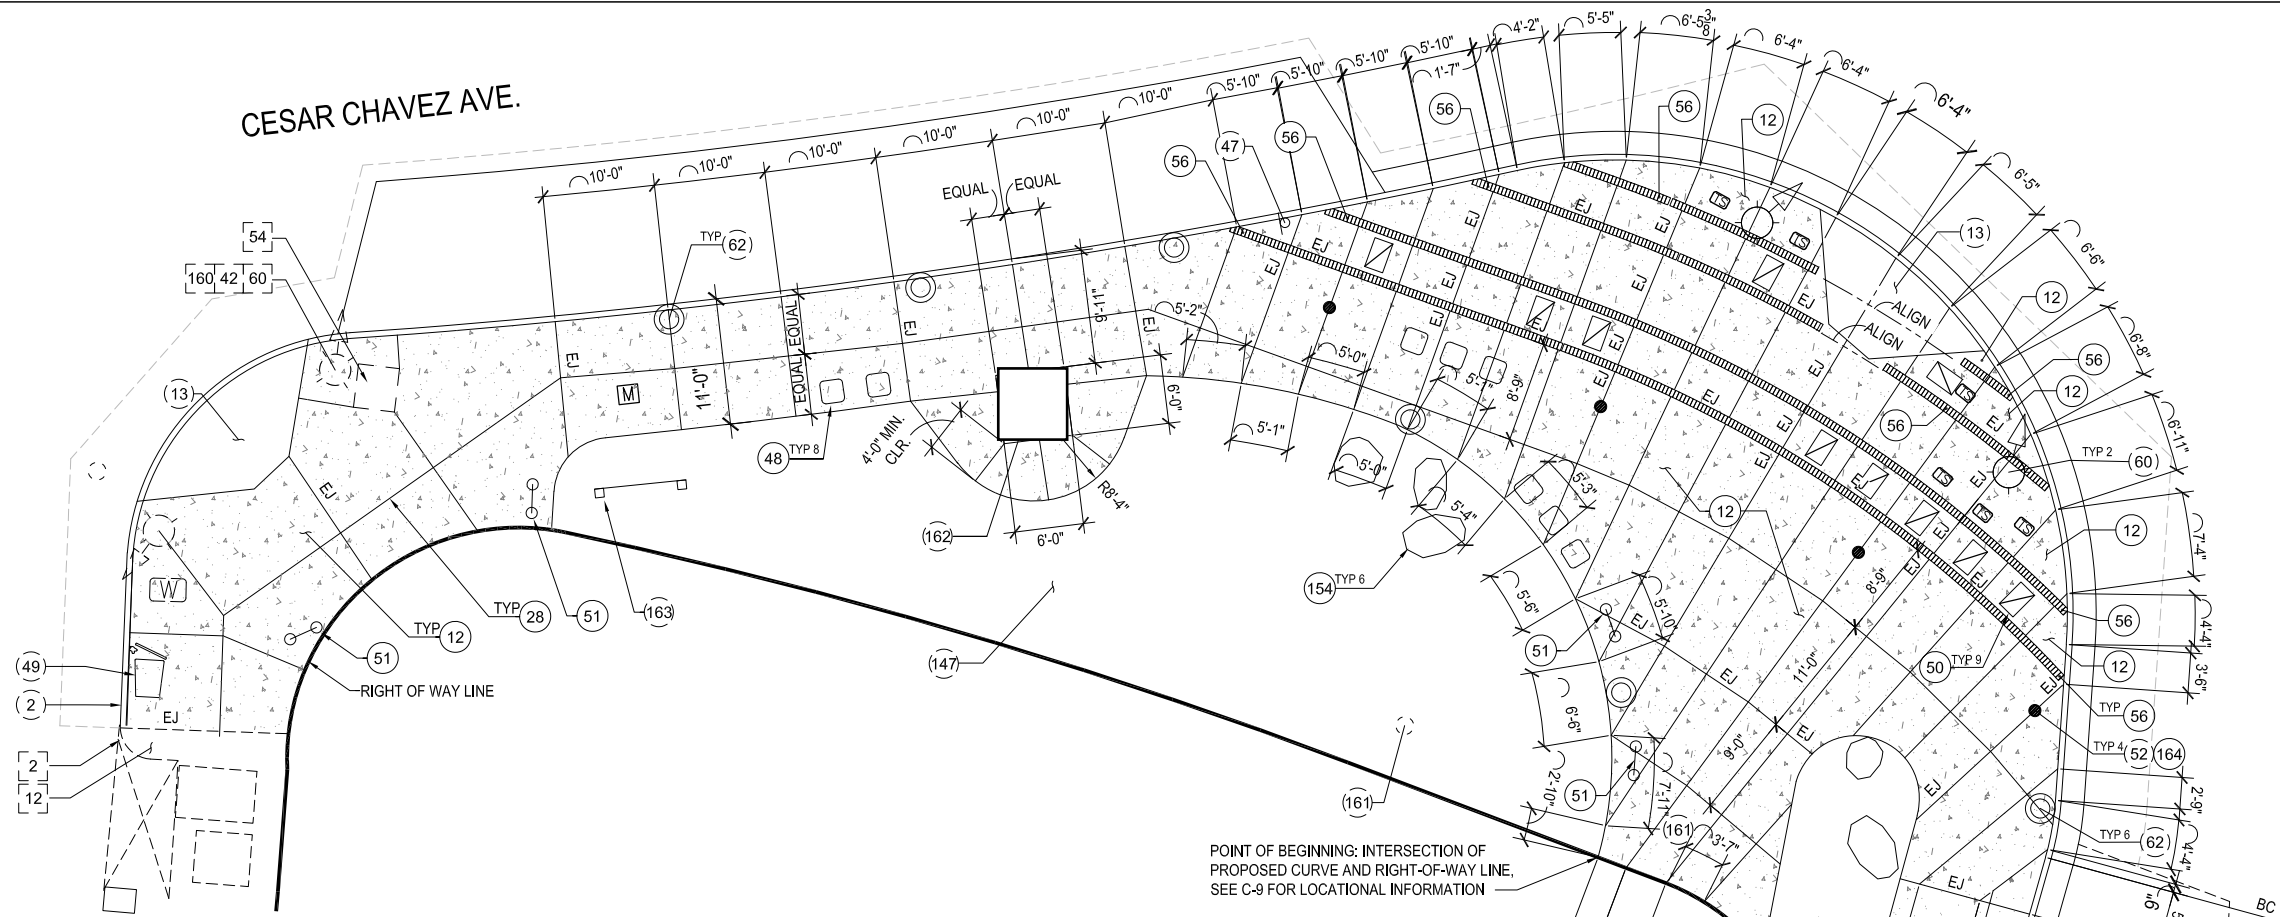

N. SPRING ST.

CESAR CHAVEZ AVE.

CURVE DATA

CURVE	LENGTH	RADIUS	ANGLE
C1	43.89'	124.16'	20.24°
C2	52.30'	113.16'	26.41°
C3	43.89'	124.16'	20.24°
C4	52.30'	113.16'	26.41°
C5	53.46'	110.63'	27.69°

N=1843640.1859
E=6489102.3612
(86° 5' 44" PER FB
132-213 PG 205)

N=18433646.3552
E=6489093.2239

GRAPHIC SYMBOLS

- EX. METAL FENCE
- TIMBER POLE
- ⊕ BENCHMARK
- ⊥ POLE ANCHOR
- ☐ TRASH RECEPTACLE
- ◇ SEATING
- EJ EXPANSION JOINT
- ⬠ BRONZE PLAQUE
- ⊙ STREETLIGHT
- ⊙ PEDESTRIAN LIGHT
- ⊙ EX. SIGNAL/LIGHT POLE
- ⊙ SIGNAL/LIGHT POLE
- ⊕ FIRE HYDRANT
- ☐ UTILITY EQUIPMENT
- ☐ PULL BOX OR METER

CONSTRUCTION SYMBOLS


- CONSTRUCT
- ⊙ EXISTING
- ☐ REMOVE
- CURB & GUTTER
- 12 CONCRETE WALK PER S-444, T=5-1/2", NATURAL GRAY, FINE BROOM FINISH,
- 13 CURB RAMP PER SHEET C-9
- 14 ASPHALT CONCRETE PAVEMENT, t=8"
- 16 CRUSHED MISCELLANEOUS BASE, t=4"
- 20 TREE, SEE LANDSCAPE PLAN, SHEET L-13
- 26 TREE WELL, 4' X 6' SIZE, WITH DECOMPOSED GRANITE COVER
- 28 JOINT PER S-430
- 48 SEATING, FINAL SEATING LOCATIONS TO BE APPROVED BY PROJECT MANAGER, SEE ALSO DETAIL 8, SHEET L-6
- 49 TRASH RECEPTACLE, AUTOMATED LITTER BIN (ALB)
- 50 BRONZE PLAQUES IN SIDEWALK, SEE DETAIL 4, SHEET L-6 & SHEETS L-7 & L-8
- 51 BICYCLE RACK PER S-671
- 54 UTILITY EQUIPMENT
- 52 TIMBER POLE, SEE DETAILS 1, 2, 3 ON SHEET L-6
- 56 BRICK PAVING IN SIDEWALK SEE SHEET L-2
- 60 SIGNAL POLE PER DOT
- 62 LIGHT POLE PER BSL
- 147 NEW LANDSCAPING/IMPORT SOIL, SEE SHEETS C-8, L-13
- 154 BOULDERS PER PLANTING PLAN, SEE SHEET L-13
- 161 MONITORING WELL
- 163 CONSTRUCTION CREDIT SIGN, SEE DETAIL 7, SHEET L-6
- 164 WAYFINDING SIGNS INSTALLED PER NOTE 5

NOTES:

1. ALL WORK SHALL BE PERFORMED IN THE CITY OF LOS ANGELES RIGHT-OF-WAY
2. ALL WORK SHALL BE BY BUREAU OF STREET SERVICES CITY OF L.A. (BSS) EXCEPT WHERE NOTED "WORK BY OTHERS" AS INDICATED ON THE PLAN CONSTRUCTION CALL-OUTS.
3. FOR ADJACENT AREA SITE PLAN, SEE C-2
4. FOR PLANTER, CURB, AND RAMP LAYOUTS, SEE C-9
5. INSTALL WAYFINDING SIGNS ON TIMBER POLES (TYP) SEE DETAIL 1, SHEET L-6 & SHEET L-9

LAYOUT OF SIDEWALK @ BRICK PAVERS

SCALE: 1/8" = 1'-0"

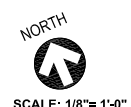

SCALE: 0 4' 8' 16'

BUREAU OF STREET SERVICES
CITY OF LOS ANGELES

REVISION	DESCRIPTION	DATE	BY

LANDSCAPE ARCHITECT
NISHITH DHANDHA
No. 3135
Expires: 3-31-17
Renewed Date: _____
LICENSED
STATE OF CALIFORNIA

DIRECTOR	DATE
NAZARIO SAUCEDA	

DEPARTMENT OF PUBLIC WORKS

ENGINEERING DIVISION

DESIGNED BY: SCOTT SHIMATSU

CHECKED BY: _____

APPROVED BY: NISHITH DHANDHA

PROJECT MGR: ROBERT GUTIERREZ

REVISION	DESCRIPTION	DATE	BY

VERTICAL CONTROL: _____

HORIZONTAL CONTROL: _____

SHEET TITLE: PAVG LAYOUT & FURNITURE PLAN

PROJECT: CESAR CHAVEZ TRANSIT CORRIDOR

ADDRESS: CESAR CHAVEZ AVENUE FROM ALAMEDA STREET - 110 FREEWAY

WORK ORDER NO. **M0014261**

DRAWING NO. **L-1**

SHEET 19 OF 32